


three inches = one foot
one and one half inches = one foot
one inch = one foot
three quarters inch = one foot
one half inch = one foot
three eighths inch = one foot
one quarter inch = one foot
one eighth inch = one foot

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LIGHTING FIXTURE SCHEDULE

TYPE	MOUNTING	VOLTS	LAMPS NUMBER & TYPE	NOMINAL FIXTURE WATTS	MANUFACTURER & CAT.# (OR APPROVED EQUAL)	DESCRIPTION	NOTES
A1	RECESSED	277	LED	38.1	METALUX 22AC-LD4-38-UNV-L835-SD1	2' X 2' LED FULL DISTRIBUTION LUMINAIRE WITH ELECTRONIC DRIVER.	-
A2	RECESSED	277	LED	44.0	METALUX 22AC-LD4-44-UNV-L835-SD1	2' X 4' LED FULL DISTRIBUTION LUMINAIRE WITH ELECTRONIC DRIVER.	-
A3	RECESSED	277	LED	68.0	METALUX 22AC-LD4-68-UNV-L835-SD1	2' X 4' LED FULL DISTRIBUTION LUMINAIRE WITH ELECTRONIC DRIVER.	-
B	SURFACE	120	LED	12" - 4W 21" - 7W 24" - 8W 33" - 12W 42" - 15W	HALO HU10 SERIES	LED UNDERCABINET WITH FROSTED GLASS DIFFUSER AND ELECTRONIC DRIVER	1
C1	RECESSED	277	LED	32.0	METALUX 2GR-LD1-32-A125-UNV-L835-SD1	2' X 2' LED WITH 0.125 INCH THICK ACRYLIC PRISMATIC LENS AND ELECTRONIC DRIVER	2
C2	RECESSED	277	LED	48.6	METALUX 2GR-LD1-48-A125-UNV-L835-SD1	2' X 4' LED WITH 0.125 INCH THICK ACRYLIC PRISMATIC LENS AND ELECTRONIC DRIVER	-
C3	RECESSED	277	LED	64.7	METALUX 2GR-LD1-64-A125-UNV-L835-SD1	2' X 4' LED WITH 0.125 INCH THICK ACRYLIC PRISMATIC LENS AND ELECTRONIC DRIVER	-
C4	RECESSED	277	LED	85.0	METALUX 2GR-LD1-85-A125-UNV-L835-SD1	2' X 4' LED WITH 0.125 INCH THICK ACRYLIC PRISMATIC LENS AND ELECTRONIC DRIVER	-
D1	RECESSED	277	LED	14.4	POTRFOLIO LD6A10D010TE-ERM6A10835-6LM1LI	8 INCH DIAMETER OPEN LED DOWN LIGHT WITH CLEAR ALZAK REFLECTOR AND ELECTRONIC DRIVER	3
D2	RECESSED	277	LED	21.0	POTRFOLIO LD6A20D010TE-ERM6A20835-6LM1LI	8 INCH DIAMETER OPEN LED DOWN LIGHT WITH CLEAR ALZAK REFLECTOR AND ELECTRONIC DRIVER	3
D3	RECESSED	277	LED	26.5	POTRFOLIO LD6A20D010TE-ERM6A20835-6LM1LI	8 INCH DIAMETER OPEN LED DOWN LIGHT WITH CLEAR ALZAK REFLECTOR AND ELECTRONIC DRIVER	3
D4	RECESSED	277	LED	38.8	POTRFOLIO LD6A30D010TE-ERM6A30835-6LM1LI	8 INCH DIAMETER OPEN LED DOWN LIGHT WITH CLEAR ALZAK REFLECTOR AND ELECTRONIC DRIVER	3
E	UNIVERSAL	277	LED	5.0	SUREILTES CX7 SERIES	LED EXIT LIGHT WITH BRUSHED ALUMINUM STENCIL FACE, RED LETTERS, UNIVERSAL ARROWS, UNIVERSAL MOUNTING AND BLACK HOUSING.	-
F	WALL	277	LED	10.0	DAYOLITE CRESL-A-DI-35-SO-2-WM-W-U	2' DIRECT / INDIRECT CRESCENT SHAPED LED WITH ACRYLIC SHIELDING TOP & BOTTOM, WHITE FINISH AND ELECTRONIC DRIVER. MOUNTED ABOVE MIRRORS.	4
H	RECESSED	277	2-26W - CFL	60.0	POTRFOLIO CD6226E-6CLH2261LI-G4	6 INCH DIAMETER COMPACT FLUORESCENT ENCLOSED AND GASKETED DOWN LIGHT WITH CLEAR FRESNEL LENS, GASKETED TRIM RING AND ELECTRONIC BALLAST	-
L	RECESSED	277	2-18W, CFL	40.0	POTRFOLIO CD6118E-6CH142W-L1	7 INCH DIAMETER OPEN DOWN LIGHT WITH TWIN DUAL LAMPS, CLEAR OVERLAP REFLECTOR/FLANGE AND ELECTRONIC BALLAST	-
L1	RECESSED	277	2-18W, CFL	40.0	POTRFOLIO CD6218E-6CH226W-L1	7 INCH DIAMETER OPEN DOWN LIGHT WITH TWIN DUAL LAMPS, CLEAR OVERLAP REFLECTOR/FLANGE AND ELECTRONIC DIMMING BALLAST	-
M1	RECESSED	277	2-U32W, T-8	70.0	METALUX 2RDI-S-2BX40	2' X 2' FLUORESCENT CENTER BASKET TROFFER, 22GA DIE-FORMED HOUSING, WHITE PERFORATED DIFFUSER AND PROGRAMMED START ELECTRONIC BALLAST	2
M3	RECESSED	277	3-32W, T-8	90.0	METALUX 2RDI-332RP	2' X 4' FLUORESCENT CENTER BASKET TROFFER, 22GA DIE-FORMED HOUSING, WHITE PERFORATED DIFFUSER AND PROGRAMMED START ELECTRONIC BALLAST	2
N	PENDANT	TBD	LED	43.5	VIBIA - RHYTHM MODEL REFERENCE 2130	DECORATIVE LED WITH FROSTED ADJUSTABLE LENS MODULES AND LED ARRAYS. FINISH MATTE OFF-WHITE.	-
P	PENDANT	277	LED	42W	CORELITE J2-WL-2L35-1C-UNV-4	4' LONG PENDANT MOUNTED SEMI-INDIRECT LED WITH 35% UP LIGHT / 65% DOWN LIGHT, 1000 LUMENS PER FOOT, 3500 KELVIN COLOR TEMPERATURE, WHITE FINISH AND 277 VOLT DIMMABLE DRIVER.	-
P1	PENDANT	277	F-54, T-5 HO	175.0	CORELITE J2-WL-3T5-1D-UNV-AC48-XX-4-DL3	4' LONG PENDANT MOUNTED SEMI-INDIRECT LED WITH 15% UP LIGHT / 85% DOWN LIGHT, 3500 KELVIN COLOR TEMPERATURE, WHITE FINISH AND 277 VOLT DIMMABLE BALLAST.	-
R	WALL	277	LED	42W PER 4'	CORELITE JAYLUM J2W-WM-2L35-1C-UNV-SU-WA	WALL MOUNTED SEMI-DIRECT LED WITH 80% DOWN LIGHT / 20% UP LIGHT, 1000 LUMENS PER FOOT, 3500 KELVIN COLOR TEMPERATURE, FLAT BALDE LOUVERS, WHITE FINISH AND 277 VOLT DRIVER. FIXTURE SHALL BE CONTINUOUS RUN OF 8' & 4' LEGNTHS AS INDICATED ON THE DRAWINGS.	-
T	RECESSED	277	F40TT, CFL	160.0	FAILSAFE MPR-G-640BX	MULTI-FUNCTIONAL COMPACT FLUORESCENT EXAM ROOM LIGHT WITH THREE LIGHTING MODES, 1) EXAM LIGHT, 2) READING LIGHT, 3) GENERAL AMBIANT LIGHT. PROVIDE WITH ELECTRONIC BALLASTS AND LOW VOLTAGE CONTROLLER.	-

- NOTES:
1. FIXTURE TYPE 'B' - PROVIDE UNDERCABINET LIGHT FIXTURES LEGNTHS TO SUIT UNDERSIDE OF OVERHEAD CABINETS FURNISHED BY OTHERS.
 2. FIXTURE TYPE 'C1', 'M1', 'M3' - PROVIDE SUITABLE MOUNTING IN (G) GRID LAY-IN TYPE CEILING OR (F) FLANGE TYPE DRYWALL CEILING. COORDINATE FIXTURE AND CEILING TYPES AS INDICATED ON THE DRAWINGS.
 3. FIXTURE TYPE 'D2,3,4' - PROVIDE WITH (DM) DIMMING TYPE BALLAST WHERE DIMMER TYPE CONTROL SWITCHES ARE INDICATED ON THE DRAWINGS.
 4. PROVIDE WITHOUT SWITCH AND CONVENIENCE OUTLET.

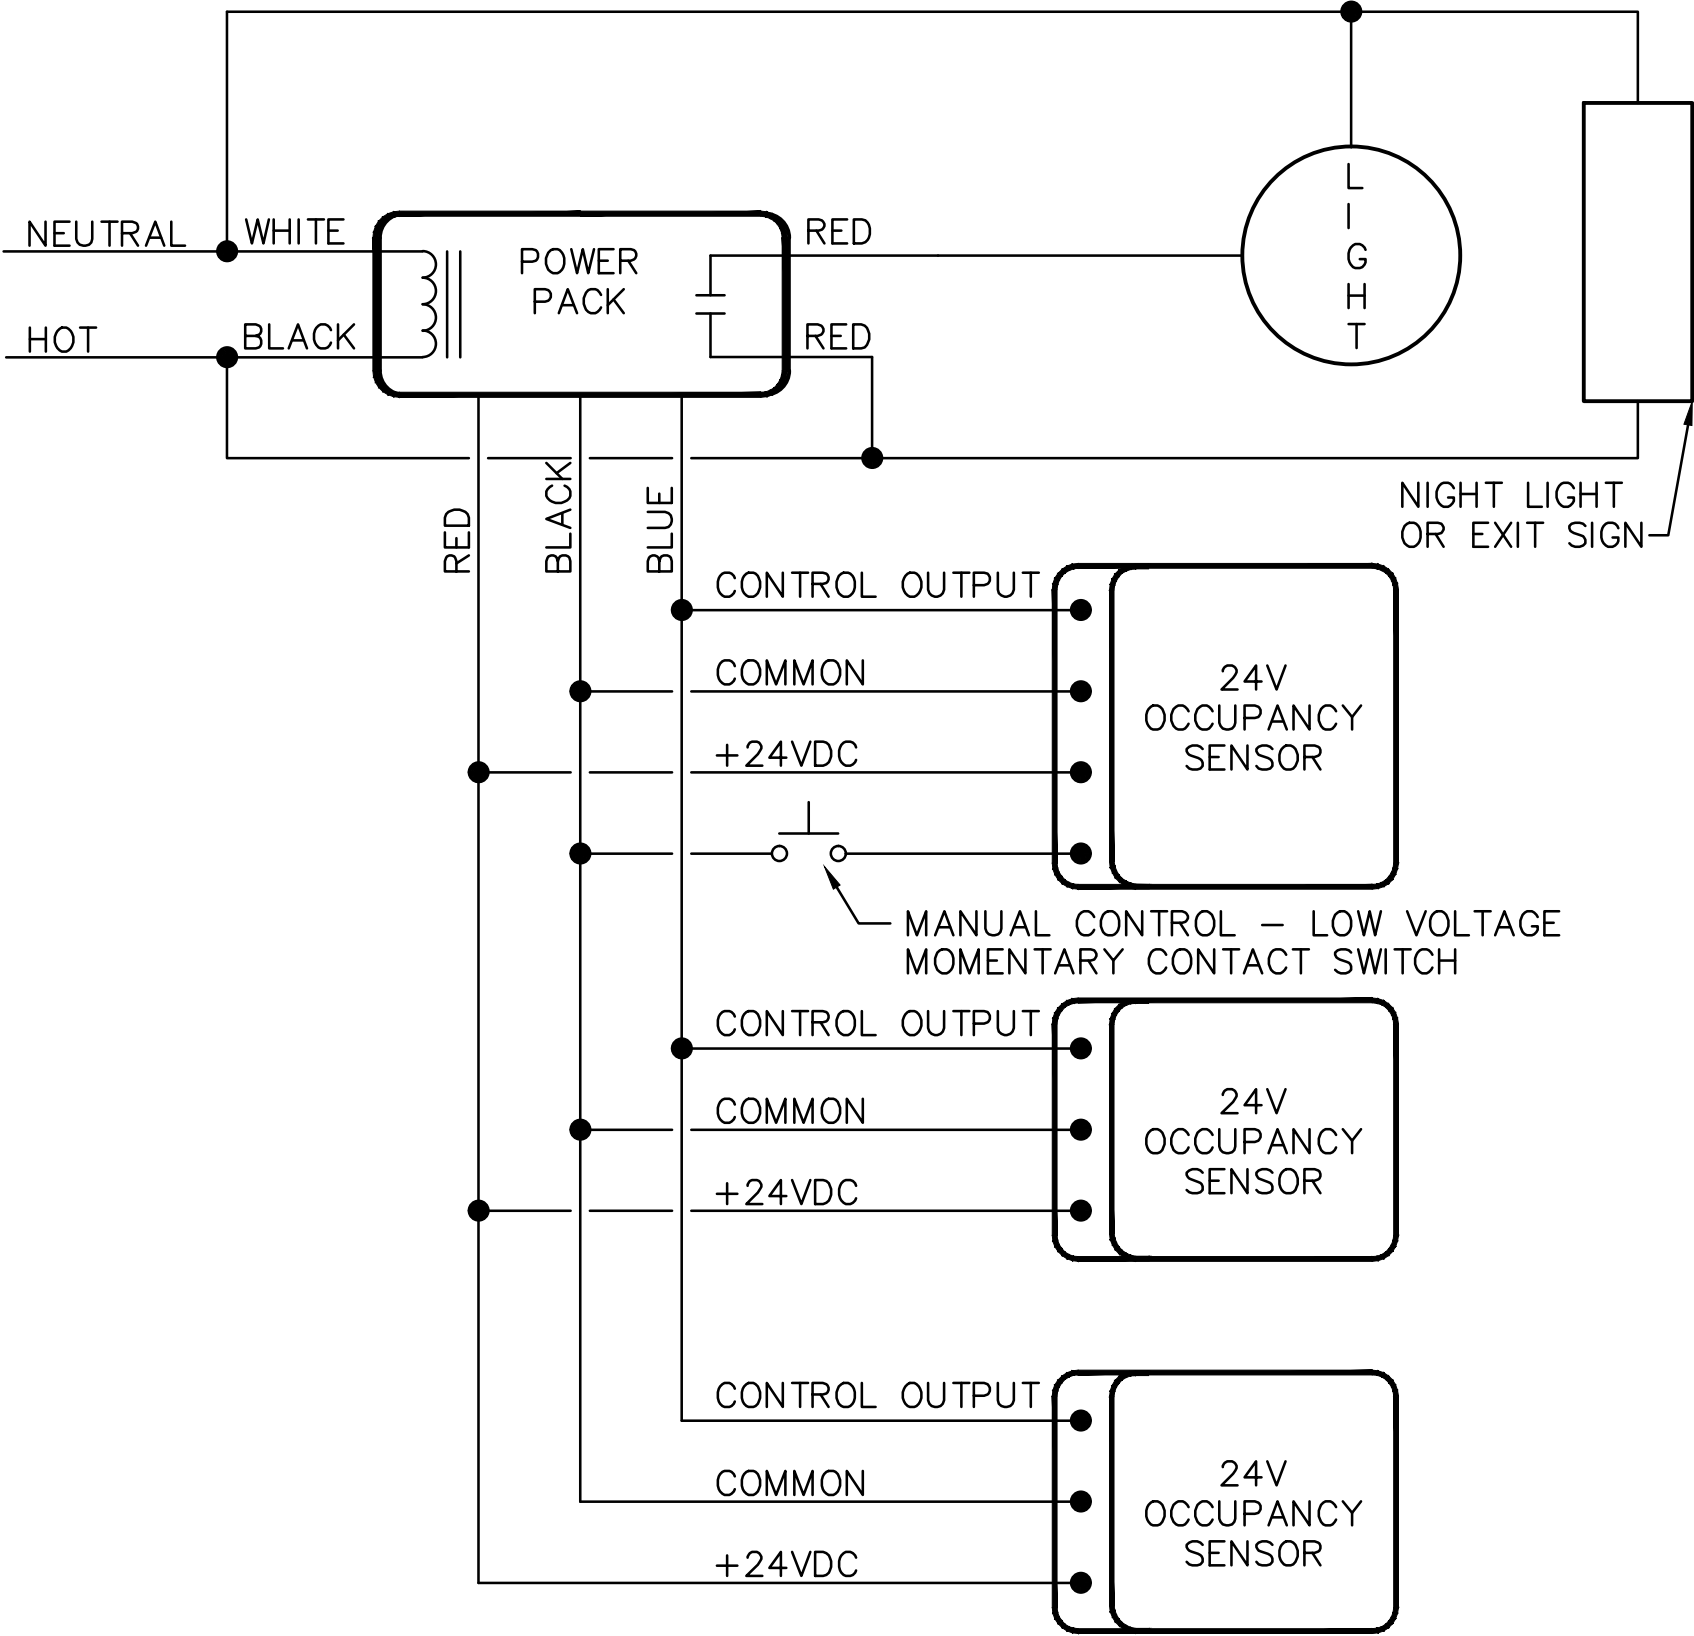

24V DC VACANCY SENSOR WIRING DETAIL

- NOTES:
1. THREE SENSORS SHOWN FOR REFERENCE ONLY. ACTUAL NUMBER OF SENSORS AS SHOWN ON THE DRAWINGS. POWER PACK SHALL BE LOCATED IN THE AREA THAT IT SERVES ABOVE AN ACCESSIBLE CEILING.
 2. LOW VOLTAGE MOMENTARY CONTACT SWITCH SHALL BE WIRED IN ROOMS WHERE SHOWN ON THE FLOOR PLANS. SWITCH SHALL TURN LIGHTS "ON" AND VACANCY SENSOR SHALL TURN LIGHTS "OFF". SWITCHES SHALL NOT BE USED IN CORRIDORS, STAIRWELLS AND LOBBIES.
 3. SEE PLANS FOR LOW VOLTAGE SWITCH LOCATION. PROVIDE LOW VOLTAGE WIRING AS REQUIRED BY THE MANUFACTURER AND INSTALL RACEWAY.

GENERAL NOTES – TELE/COMM:

1. ALL DATA/COMM OUTLET LOCATIONS SHALL BE SERVED WITH A TRIPLEX CAT6 CABLE THAT SHALL CONSIST OF 2 DATA AND 1 VOICE CABLES.
2. DATA-1 CABLE SHALL BE ORANGE CAT6.
3. DATA-2 CABLE SHALL BE YELLOW CAT6.
4. VOICE CABLE SHALL BE WHITE CAT6.
5. JACKS AND FACE PLATE SHALL BE PANDUIT GIGA-JACK BRAND, PART NUMBERS CJ5E88TOR (ORANGE JK), CJ5E88TYL (YELLOW JK), CJ5E88TWH (WHITE JK) WITH FACE-PLATES- CFPE4E1Y. 1 MINI COMM BLANK SHALL BE PLACED IN THE OPEN PORT.
6. DATA-1 AND DATA-2 SHALL BE ON SEPARATE CAT6 PATCH PANELS.
7. ALL CABLES SHALL BE RUN UP INTO INTERSTITIAL SPACE VIA EXISTING COMMUNICATIONS WIREWAYS TO DATA/VOICE CLOSET. PROVIDE A 10' SERVICE LOOP TO BE LEFT ON CABLE TRAY. VOICE CABLES SHALL BE TERMINATED ON (CAT6) 110 BLOCKS AND C4 CLIPS ON EXISTING BACK BOARD. ALL LOCATIONS SHALL BE LABELED WITH THE IDF ROOM NUMBER AND PORT #.
8. ALL CABLES SHALL BE TESTED TO CAT6E STANDARDS. TEST RECORDS SHALL BE TURNED OVER TO THE VA TELECOM DEPARTMENT FOR REVIEW AND APPROVAL.
9. ALL CABLE RUNS SHALL BE SELF-SUPPORTED VIA J HOOKS OR APPROVED HANGERS PRIOR TO ENTERING THE INTERSTITIAL SPACE.
10. ANY PENETRATIONS SHALL BE FIRE STOPPED BY THE CONTRACTOR.
11. FOR EACH TRIPLEX LOCATION INSTALLED PROVIDE A 12' PATCH CABLE AT THE JACK LOCATION AND A 6' PATCH CABLE AT THE PATCH PANEL END. PATCH CABLES TO MATCH THE JACK COLOR.
12. VENDOR REPRESENTATIVES AND TECHNICIANS SHALL BE BICSI TRAINED, CERTIFIED AND AUTHORIZED TO PERFORM ALL INSTALLATION TASKS.
13. VENDOR SHALL PROVIDE ALL NECESSARY TRANSPORTATION, PARTS, SUPPLIES, MATERIALS AND LABOR TO ACCOMPLISH ALL TASKS.
14. WORK TO BE ACCOMPLISHED SHALL BE TO PERFORM ALL INSTALLATION TO THE MANUFACTURER'S SPECIFICATIONS OF NORMAL OPERATING PARAMETERS AND SAFETY POLICY.
15. ALL WARRANTY OF SAID WORK SHALL BE FOR A PERIOD OF 1 YEAR FROM DATE OF FINAL ACCEPTANCE BY THE VA.

GENERAL NOTES – INTERCOM & WIRELESS ROUTER SYSTEMS:

1. THE INTERCOM AND WIRELESS ROUTER SYSTEMS ARE CURRENTLY BEING UPDATED AND INSTALLED AT THE TIME OF THIS DESIGN. DRAWINGS OF THESE SYSTEMS HAVE NOT BEEN PROVIDED AS OF THIS SUBMISSION FOR INCLUSION OF THE SET. SEE DRAWING ED-105, GENERAL NOTE 4 AND DRAWING EP-101, GENERAL NOTE 2 FOR ADDITIONAL INFORMATION.

ELECTRICAL LEGEND

SYMBOL	DESCRIPTION
	LIGHTING FIXTURE – FLUORESCENT OR LED – TYPE AS INDICATED
	LIGHTING FIXTURE – COMPACT FLUORESCENT OR LED – CEILING, WALL MOUNTED – TYPE AS INDICATED
	LIGHTING FIXTURE ON EMERGENCY OR NIGHT LIGHT CIRCUIT
	EXIT LIGHT – CEILING, WALL MOUNTED – SHADED AREA INDICATES ILLUMINATED FACE – PROVIDE DIRECTIONAL ARROWS AS INDICATED – WALL MOUNTING HEIGHT 7'-6"
S_1, S_2, S_3, S_4, S_o	SWITCH – SINGLE POLE, DOUBLE POLE, THREE WAY, FOUR WAY, SUBSCRIPT DENOTES OUTLETS CONTROLLED – MOUNTING HEIGHT 4'-0"
	DIMMING SWITCH – MOUNTING HEIGHT 4'-0"
	DUPLEX RECEPTACLE – 20A., 125V. – MOUNTING HEIGHT 18" UNLESS NOTED OTHERWISE
	DUPLEX RECEPTACLE – 20A., 125V. – MOUNTING HEIGHT 18" UNLESS NOTED OTHERWISE ON EMERGENCY CIRCUIT. DEVICE AND DEVICE PLATE COLOR SHALL BE RED.
	GFI RECEPTACLE – 20A., 125V. – MOUNTING HEIGHT 18" UNLESS NOTED OTHERWISE
	DOUBLE DUPLEX RECEPTACLE – 20A., 125V. – MOUNTING HEIGHT 18" UNLESS NOTED OTHERWISE
	CEILING RECEPTACLE – 20A., 125V. – DUPLEX – FLUSH IN CEILING
	SPECIAL PURPOSE RECEPTACLE – FLOOR, WALL MOUNTED – TYPE AS INDICATED OR SCHEDULED – MOUNTING HEIGHT 18" UNLESS NOTED OTHERWISE
	TWO CHANNEL POWER/DATA COMM POLE
	CLOCK HANGER/OUTLET – TYPE AND MOUNTING AS NOTED OR SPECIFIED
	TELEPHONE OUTLET – WALL MOUNTED – MOUNTING HEIGHT 18" UNLESS NOTED OTHERWISE
	DATA OUTLET – WALL MOUNTED – MOUNTING HEIGHT 18" UNLESS NOTED OTHERWISE
	TELEPHONE/DATA OUTLET – WALL MOUNTED – MOUNTING HEIGHT 18" UNLESS NOTED OTHERWISE
	JUNCTION BOX – CEILING, WALL MOUNTED – SIZE PER NEC OR AS INDICATED
	PANELBOARD – TYPE AS NOTED – MOUNTING HEIGHT 6'-6" TO TOP
	SPECIAL CABINET – TYPE AS NOTED
	CONDUIT – IN OR ON CEILING OR WALLS
	CONDUIT – IN OR UNDER FLOOR
	HOMERUN TO PANEL – NUMBER OF ARROWS INDICATE NUMBER OF CIRCUITS AND NUMBER OF CROSSLINES INDICATES NUMBER OF #12 PHASE & NEUTRAL CONDUCTORS – WHERE NO CROSSLINES APPEAR 2#12 CONDUCTORS ARE IMPLIED. GROUND WIRE IS NOT SHOWN BUT REQUIRED. PROVIDE #12 GROUND WIRE UNLESS OTHERWISE INDICATED.
	CONDUIT – EXISTING
	CONDUIT – TURNING UP OR DOWN AS REQUIRED
	TELEVISION ANTENNA OUTLET – 75 OHM COAXIAL – MOUNTING HEIGHT 18"
	MOTOR – HORSEPOWER AS NOTED
	SPEAKER – CEILING, WALL – 'F' DENOTES FIRE ALARM SPEAKER SYSTEM DEVICE
	NURSE CALL DUTY STATION – MOUNTING HEIGHT 4'-6"
	NURSE CALL PATIENT LIGHT – CEILING MOUNTED
	NURSE CALL MASTER STATION
	NURSE CALL EMERGENCY TOILET STATION – MOUNTING HEIGHT 2'-0"
	SWITCH/VACANCY SENSOR – WALL MOUNTED MOUNTING HEIGHT 4'-0"
	VACANCY SENSOR – CEILING MOUNTED
	VACANCY POWER PACK – TYPE AS NOTED

ABBREVIATIONS

A	AMPERE
AC	ALTERNATING CURRENT
ACU	AIR CONDITIONING UNIT
AFF	ABOVE FINISHED FLOOR
AFG	ABOVE FINISHED GRADE
AIC	AMPERES INTERRUPTING CAPACITY
AL	ALUMINUM
ATS	AUTOMATIC TRANSFER SWITCH
AUX	AUXILIARY
BKR	BREAKER
C	CONDUIT
CAT	CATALOG
CB	CIRCUIT BREAKER
CCTV	CLOSED CIRCUIT TELEVISION
CLF	CURRENT LIMITING FUSE
CLG	CEILING
DISC	DISCONNECT
EF	EXHAUST FAN
EMT	ELECTRICAL METALLIC TUBING
EX	EXISTING
F	FUSED OR FUSIBLE
FLA	FULL LOAD AMPERES
GFI	GROUND FAULT INTERRUPTER
GRD	GROUND
HID	HIGH INTENSITY DISCHARGE
HOA	HAND-OFF-AUTOMATIC
HP	HORSEPOWER
HZ	HERTZ
IMC	INTERMEDIATE METAL CONDUIT
JB	JUNCTION BOX
KCMIL	THOUSAND CIRCULAR MILS
KV	KILO-VOLTS
KVA	KILO-VOLTS-AMPERES
KW	KILOWATTS
KWH	KILOWATT HOURS
LTG	LIGHTING
MIN	MINIMUM
MISC	MISCELLANEOUS
MLO	MAIN LUGS ONLY
MOD	MOTOR OPERATED DAMPER
MTD	MOUNTED
NC	NORMALLY CLOSED
NEC	NATIONAL ELECTRICAL CODE
NF	NON-FUSED
NIC	NOT IN CONTRACT
NL	NIGHT LIGHT
OH	OVERHEAD
P	POLE (1P., 2P., 3P.)
RPM	REVOLUTION PER MINUTE
RX	REMOVE EXISTING
SPD	SURGE PROTECTIVE DEVICE
SPECS	SPECIFICATIONS
TEL	TELEPHONE
TV	TELEVISION
TVSS	TRANSIENT VOLTAGE – SURGE SUPPRESSOR
TYP	TYPICAL
UL	UNDERWRITERS LABORATORIES
UPS	UNINTERRUPTED POWER SUPPLY
V	VOLTS
W	WATTS
WP	WEATHERPROOF
XFMR	TRANSFORMER
XP	EXPLOSION PROOF

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Drawing Title
ELECTRICAL, DETAILS AND ABBREVIATIONS

Approved Project Director
APPROVED - BY - NAME
APPROVED - BY - TITLE/RANK
STATION - MANAGEMENT

FULLY SPRINKLERED

100% SUBMISSION

Project Title
**RENOVATE / BACKFILL
ONCOLOGY 2C,
3D SLEEP LAB AND MSO**

Location
YAMC BALTIMORE, MD.

Date
OCTOBER 1, 2014

Checked
RJH

Drawn
JEM

Project Number
512-14-102

Building Number
-

Drawing Number
EI-001

Dwg. 79 of 98

Office of
Construction
and Facilities
Management

Department of
Veterans Affairs



0 2' 4' 8' 12' $1/4"=1'-0"$



100% SUBMISSION

ED-101

Department of

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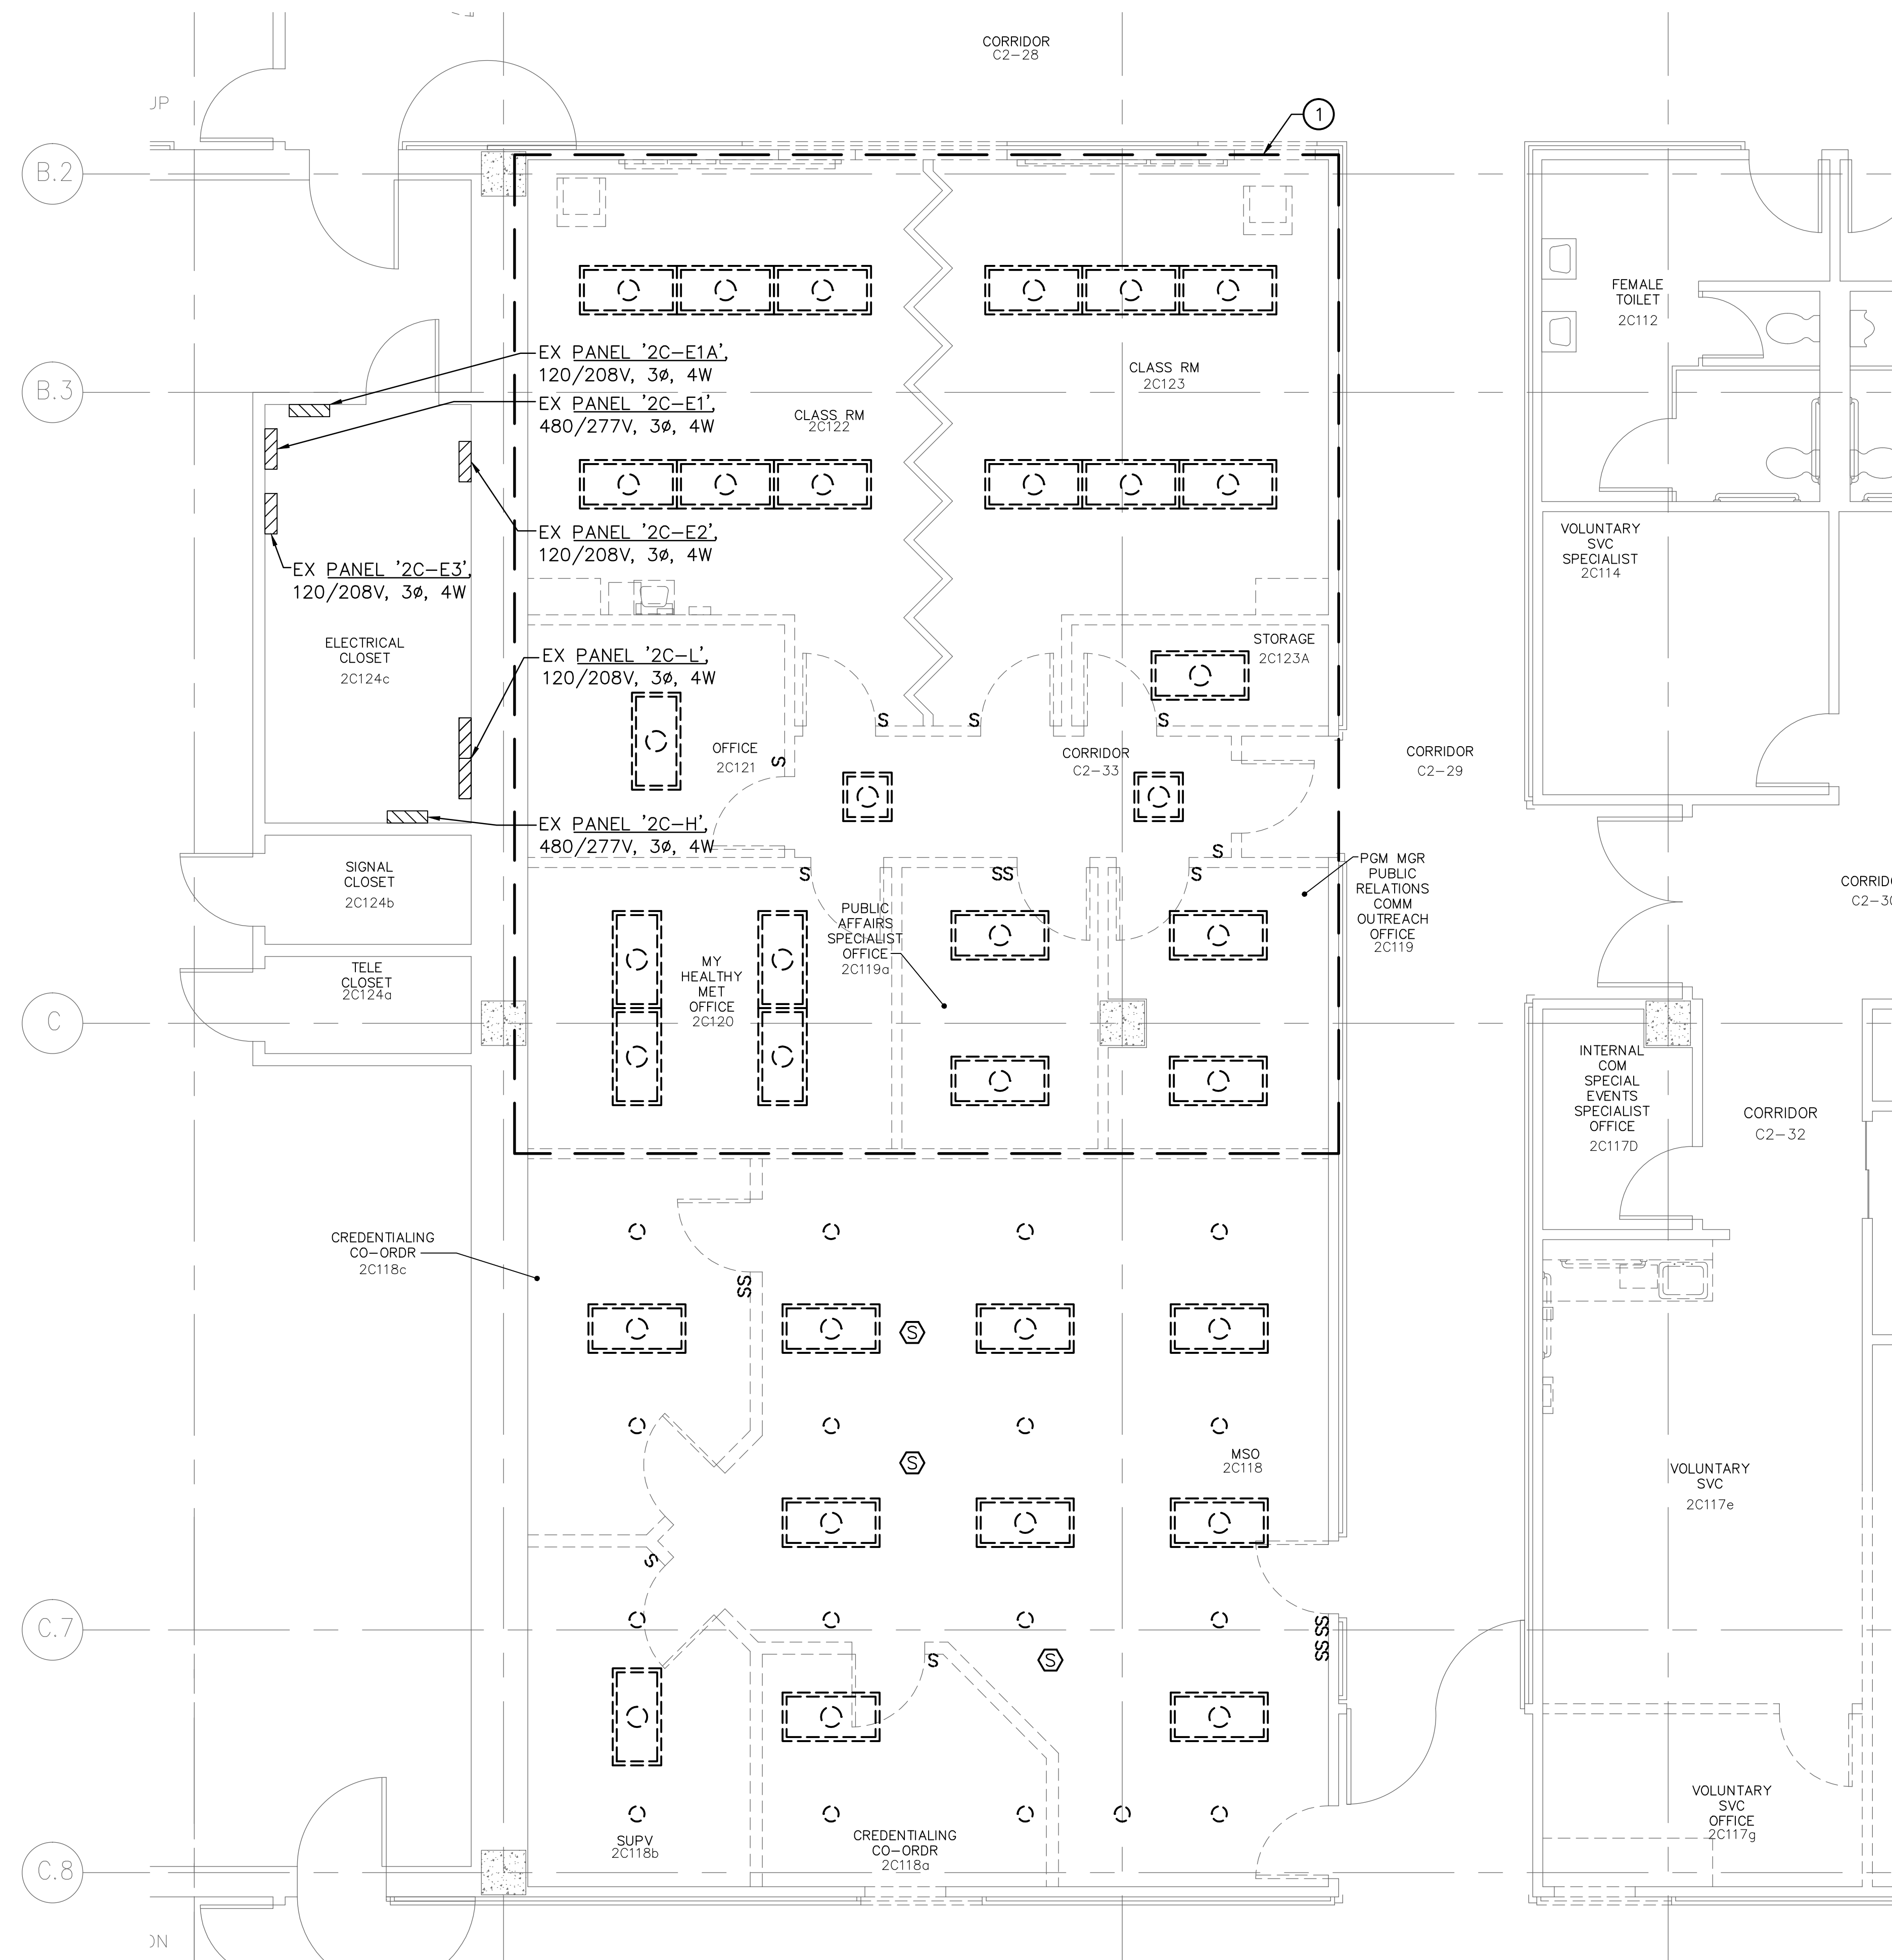
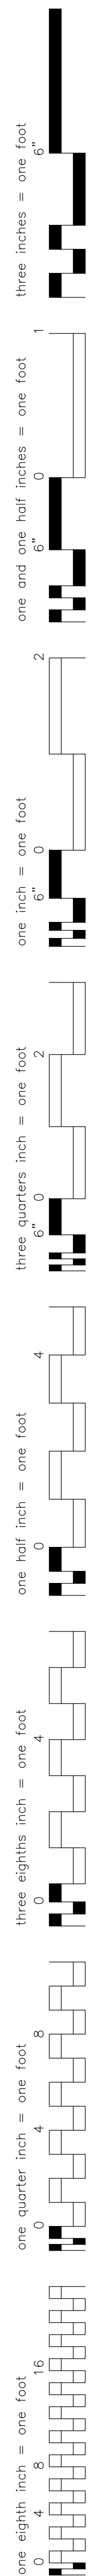


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STATION - MANAGEMENT

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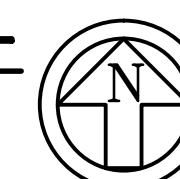
Drawing Number

Department of



**PARTIAL SECOND FLOOR PLAN – EDUCATION/MSO SUITES –
LIGHTING DEMOLITION**

SCALE: $\frac{1}{4}" = 1'-0"$



GENERAL NOTES: (APPLY TO THIS SHEET ONLY)

1. ALL ELECTRICAL CONDUITS CIRCUIT WIRING IS ROUTED UP INTO THE INTERSTITIAL SPACE VIA GROUPS OF THREE WIREWAYS TO THEIR RESPECTIVE SOURCES. ONE WIREWAY IS FOR DATA/COMM WIRING, ONE IS FOR NORMAL POWER WIRING AND ONE IS FOR EMERGENCY POWER WIRING. PROVIDE OPENINGS IN THE FLOOR OF THE INTERSTITIAL SPACE AS NECESSARY TO INSTALL NEW ELECTRICAL CONDUITS. SEAL ANY OPENINGS THAT REMAIN AFTER REMOVAL OF EXISTING CONDUIT PENETRATIONS.
2. LIGHTING FIXTURES: REMOVE ALL LIGHTING FIXTURES SHOWN DASHED OR LABELED RX. MAINTAIN ALL EXISTING CIRCUITS FOR REUSE TO CONNECT NEW LIGHTING FIXTURES. ALL UNUSED WIRE AND ACCESSIBLE CONDUIT/RACEWAYS SHALL BE REMOVED.


DRAWING NOTES: (APPLIES TO THIS SHEET ONLY)

- ① THIS AREA WILL BE USED FOR PROJECT PHASING DURING CONSTRUCTION. REFER TO DRAWING G-006 FOR PROJECT PHASING. UNDER PHASE FOUR, THE INTERIOR PARTITIONS WILL BE REMOVED. THE LIGHTING SHALL BE TEMPORARILY MAINTAINED UNTIL THE FINAL PHASE. UNDER PHASE ONE, REMOVE ALL ASSOCIATED LIGHTING CONTROL DEVICES ON THE INTERIOR PARTITIONS AND ASSOCIATED WIRE AND CONDUIT. TEMPORARILY REWORK EXISTING LIGHTING CIRCUITS AND CONTROLS AS REQUIRED. UNDER THE FINAL PHASE, COMPLETE THE ELECTRICAL DEMOLITION AS INDICATED.


CAUTION:

IF THIS PLAN IS A REDUCTION,
GRAPHIC SCALES MUST BE USED.

GRAPHIC SCALE

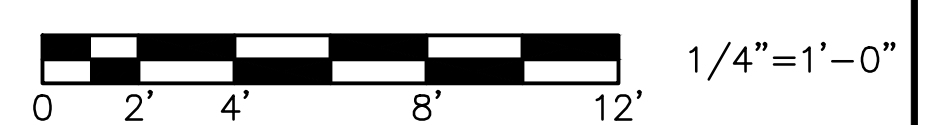

KEY PLAN

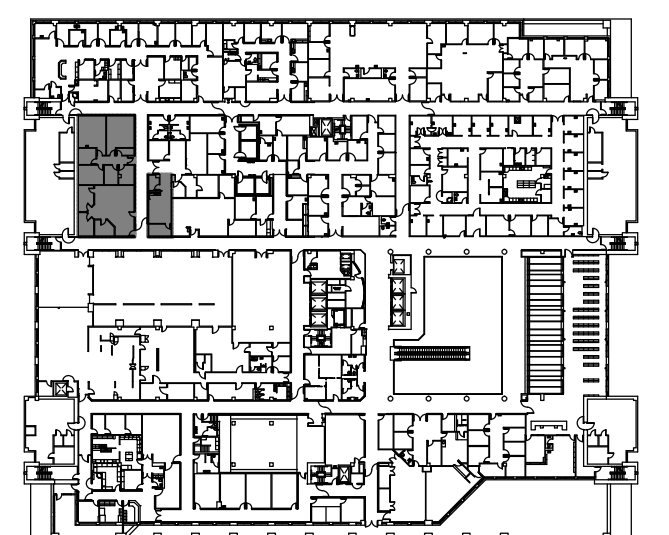

SECOND FLOOR

FULLY SPRINKLERED

100% SUBMISSION

Project Title	RENOVATE / BACKFILL ONCOLOGY 2C, 3D SLEEP LAB AND MSO
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Location	VAMC BALTIMORE, MD.
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Drawing Number	ED-102
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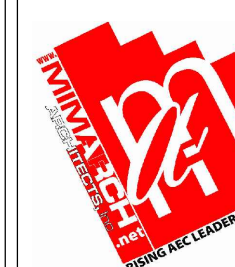
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and Facilities
Management


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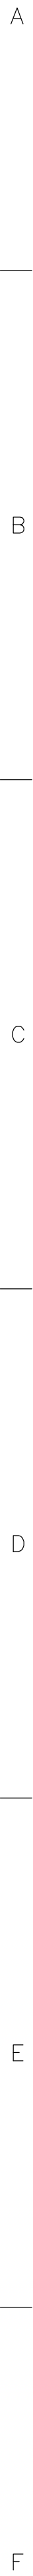


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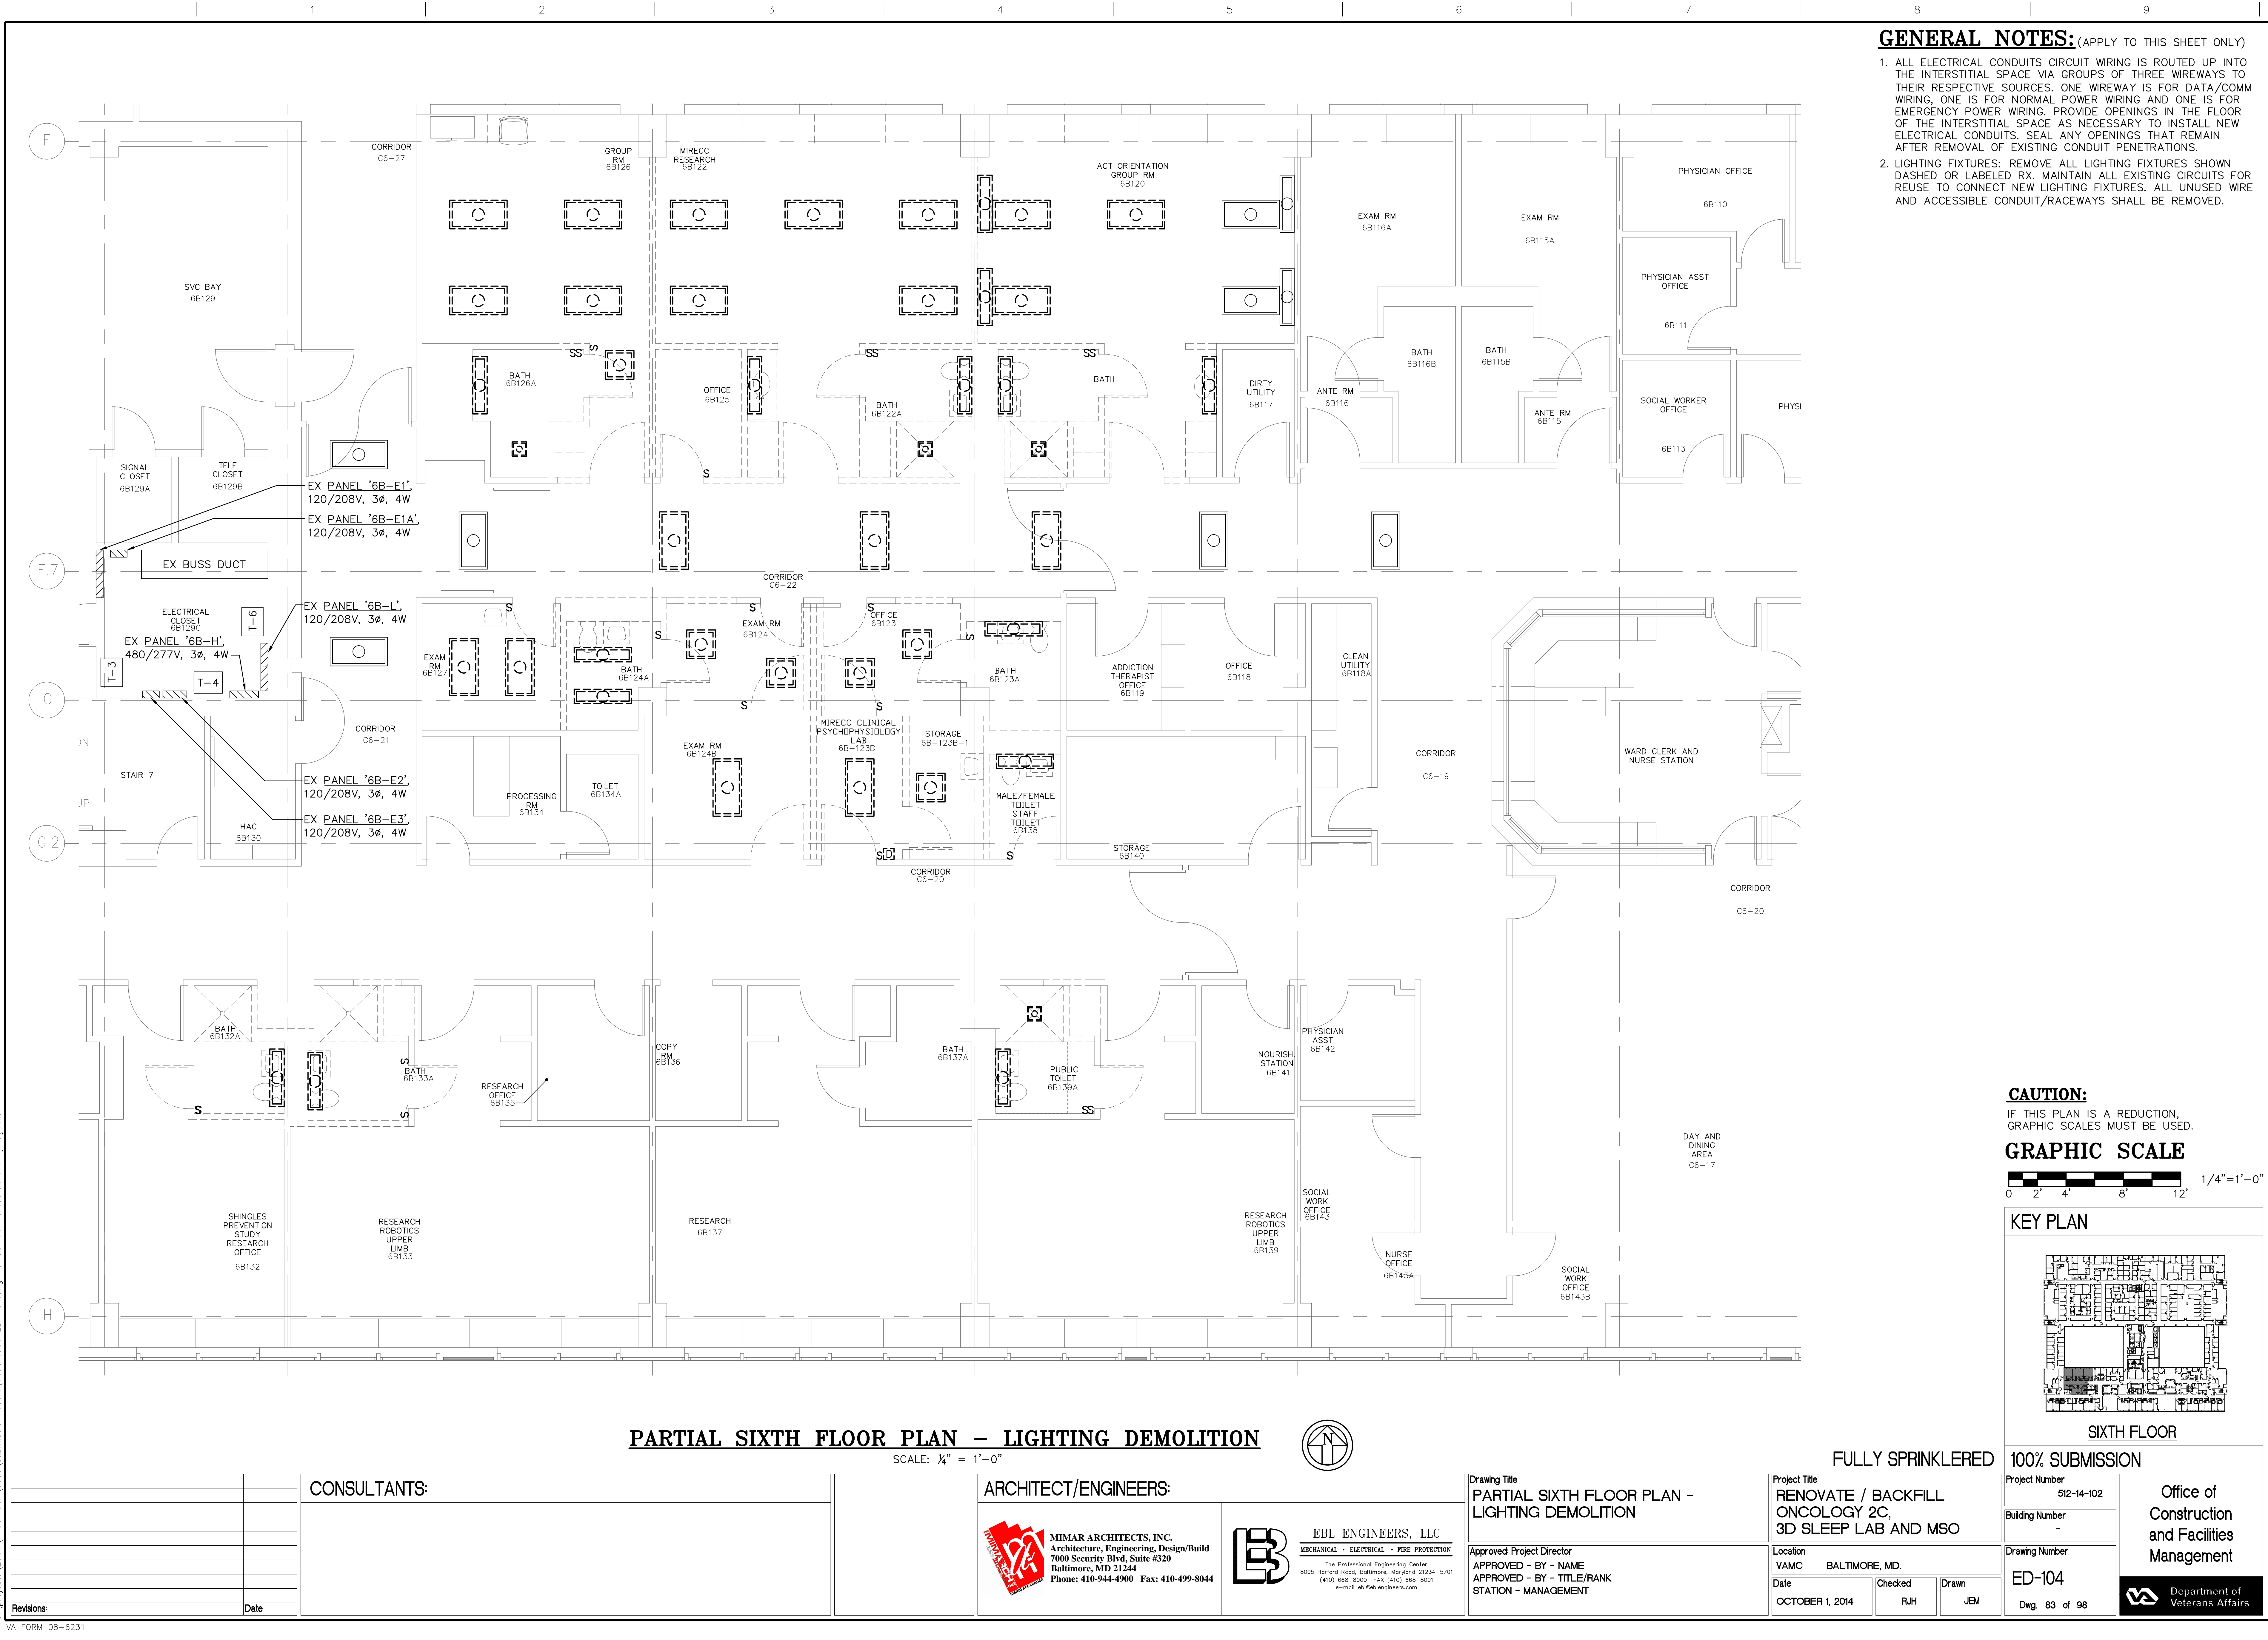
Drawing Title
PARTIAL SECOND FLOOR PLAN -
EDUCATION/MSO SUITES -
LIGHTING DEMOLITION

Approved: Project Director
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VA FORM 08-6231


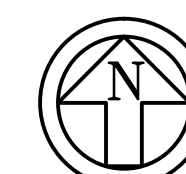


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 Department of
Veterans Affairs

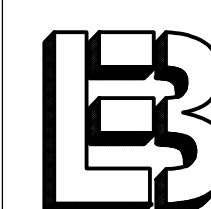SCALE: $\frac{1}{4}" = 1'-0"$



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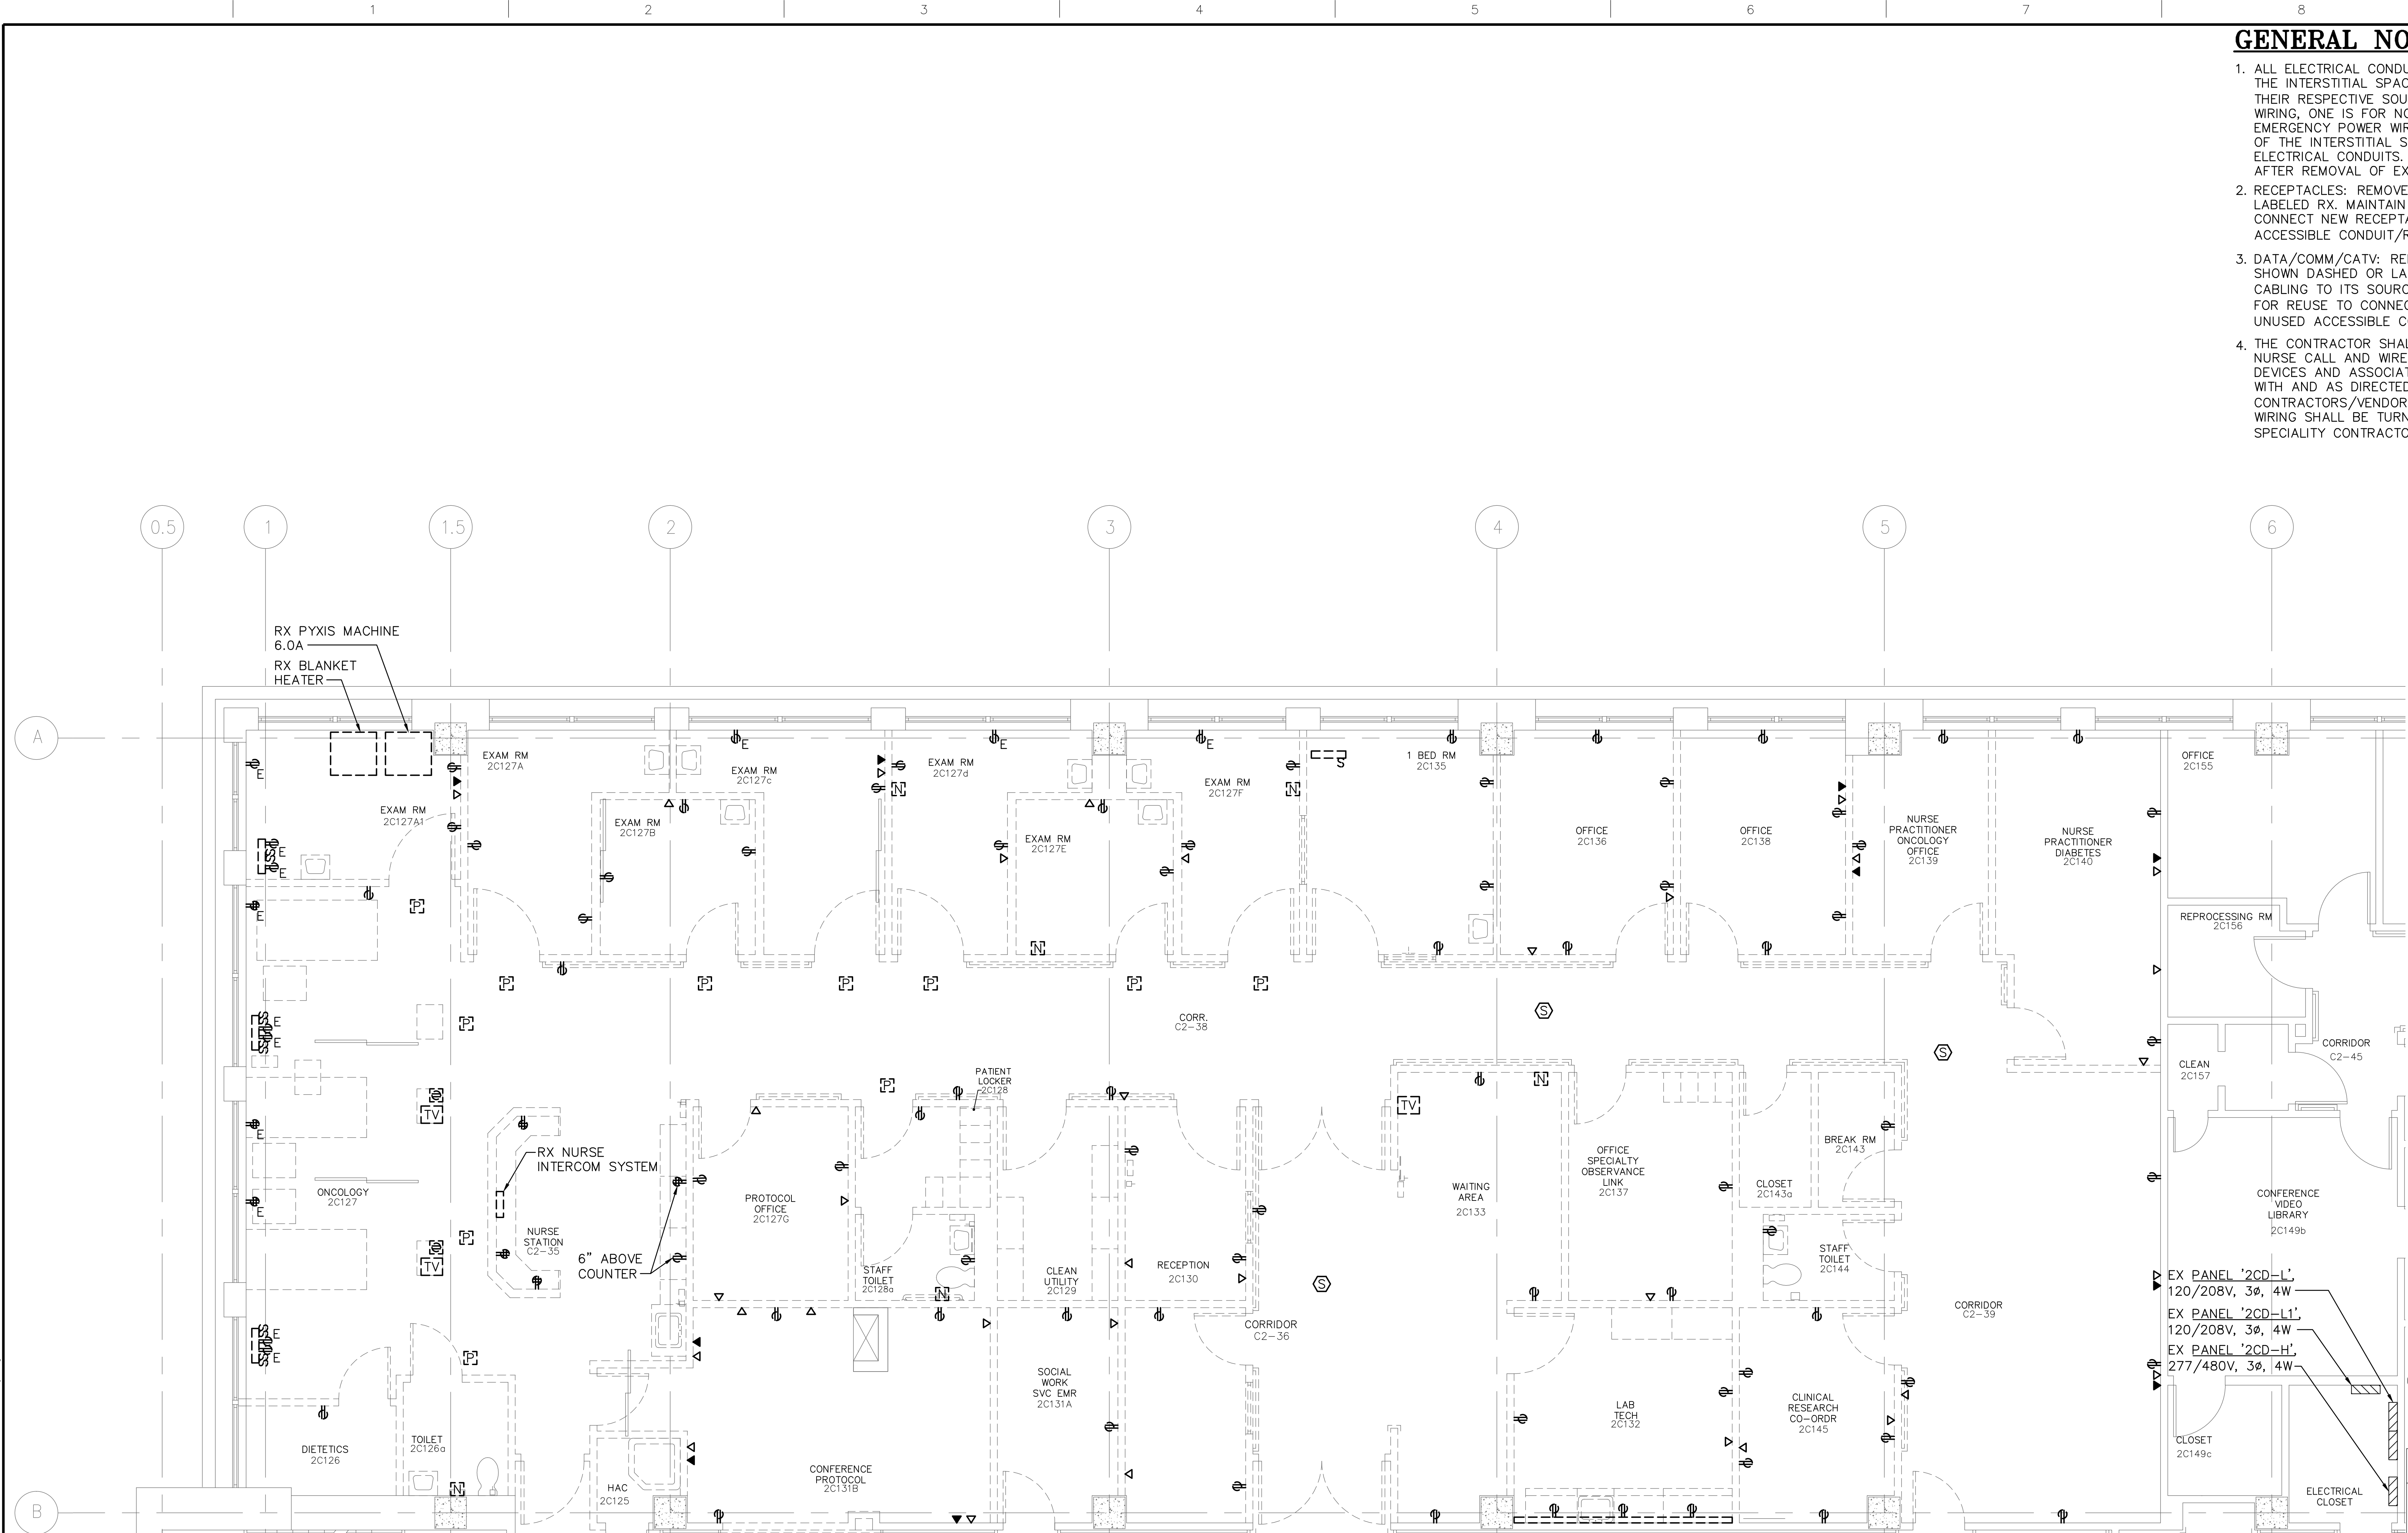
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CONSULTANTS:

ARCHITECT/ENGINEERS:

Drawing Title	PARTIAL SIXTH FLOOR PLAN - LIGHTING DEMOLITION
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three inches = one foot
one and one half inches = one foot
three quarters inch = one foot
one half inch = one foot
three eighths inch = one foot
one quarter inch = one foot
one eighth inch = one foot




GENERAL NOTES: (APPLY TO THIS SHEET ONLY)


1. ALL ELECTRICAL CONDUITS CIRCUIT WIRING IS ROUTED UP INTO THE INTERSTITIAL SPACE VIA GROUPS OF THREE WIREWAYS TO THEIR RESPECTIVE SOURCES. ONE WIREWAY IS FOR DATA/COMM WIRING, ONE IS FOR NORMAL POWER WIRING AND ONE IS FOR EMERGENCY POWER WIRING. PROVIDE OPENINGS IN THE FLOOR OF THE INTERSTITIAL SPACE AS NECESSARY TO INSTALL NEW ELECTRICAL CONDUITS. SEAL ANY OPENINGS THAT REMAIN AFTER REMOVAL OF EXISTING CONDUIT PENETRATIONS.
2. RECEPTACLES: REMOVE ALL RECEPTACLES SHOWN DASHED OR LABELED RX. MAINTAIN ALL EXISTING CIRCUITS FOR REUSE TO CONNECT NEW RECEPTACLES. ALL UNUSED WIRE AND ACCESSIBLE CONDUIT/RACEWAYS SHALL BE REMOVED.
3. DATA/COMM/CATV: REMOVE ALL DATA/COMM/CATV DEVICES SHOWN DASHED OR LABELED RX. REMOVE ALL ASSOCIATED CABLING TO ITS SOURCE. MAINTAIN EXISTING CONDUIT/RACEWAYS FOR REUSE TO CONNECT NEW DATA/COMM/CATV DEVICES. ALL UNUSED ACCESSIBLE CONDUIT/RACEWAYS SHALL BE REMOVED.
4. THE CONTRACTOR SHALL REMOVE ALL EXISTING INTERCOM, NURSE CALL AND WIRELESS ROUTER SYSTEMS INCLUDING DEVICES AND ASSOCIATED WIRING AND CONDUIT IN COOPERATION WITH AND AS DIRECTED BY THE IN-HOUSE STAFF OR SPECIALTY CONTRACTORS/VENDORS. ALL EXISTING DEVICES AND ASSOCIATED WIRING SHALL BE TURNED OVER TO THE IN-HOUSE STAFF OR SPECIALTY CONTRACTORS/VENDORS FOR RE-INSTALLATION.

CAUTION:
IF THIS PLAN IS A REDUCTION,
GRAPHIC SCALES MUST BE USED.

GRAPHIC SCALE

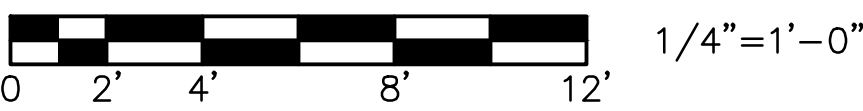


KEY PLAN

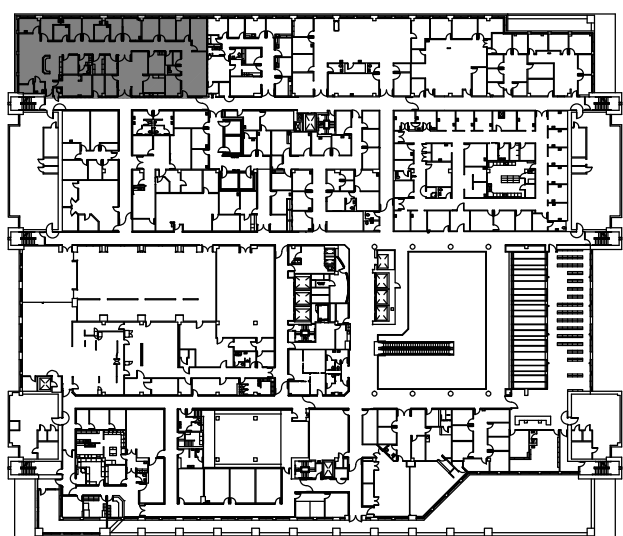

SECOND FLOOR

**PARTIAL SECOND FLOOR PLAN - ONCOLOGY/ENDOCRINOLOGY
SUITES - POWER & SYSTEMS DEMOLITION**

SCALE: 1/4" = 1'-0"

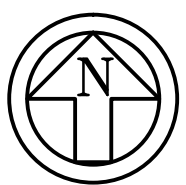

CONSULTANTS:		ARCHITECT/ENGINEERS:		Drawing Title PARTIAL SECOND FLOOR PLAN - ONCOLOGY/ENDOCRINOLOGY SUITES - POWER + SYSTEMS DEMOLITION		Project Title RENOVATE / BACKFILL ONCOLOGY 2C, 3D SLEEP LAB AND MSO		100% SUBMISSION	
				Approved Project Director APPROVED - BY - NAME APPROVED - BY - TITLE/RANK STATION - MANAGEMENT		Location YAMC BALTIMORE, MD.		Project Number 512-14-102	
						Date OCTOBER 1, 2014		Building Number -	
						Checked RJH		Drawing Number ED-105	
						Drawn JEM		Dwg. 84 of 98	
Revisions:		Date							

Office of
Construction
and Facilities
Management



